Stone Road Energy, LLC

2511 NW 6th Street, Fort Lauderdale, Florida

Owner/Client:

DOWN

FOM

GA

GALV

GRD

GD

GWB

H.C.

GALVANIZED

GYPSUM WALL BOARD

HOUSEKEEPING CLOSET

GLASS

GRADE

GUARD

HANDRAIL

Stone Road Energy, LLC 19206 Huebner Road, Suite 100 San Antonio, TX 78258 Attn: Mr. Blair Livingston blivingston@forever-propane.com

Architect:

PRE-CAST

Radakovich | Architecture Attn: Mr. Travis Radak, Esq. 2465 Mercer Ave., Suite 201 West Palm Beach, FL 33401 Ph: (561) 283-0721 tradak@radgr.com

TERRAZZO

THRESHOLD

LEFT HAND

LOCATION/ LOCAL

PROJECT MANAGER

PROJECT ARCHITECT

GENERAL CONTRACTOR

ELECTRICAL CONTRACTOR

LIGHT

OWNER


LOC

OWN

General Contractor:

Miller Construction Company Attn: Mr. Ernesto Escobar 5750 Powerline Road Fort Lauderdale, FL 33309 (954) 764-6550 eescobar@millerconstruction.com

Location Map

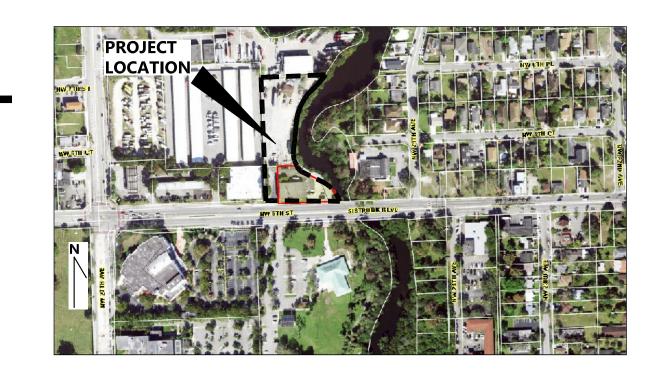

Sheet #	Sheet Title	Issued Date	Rev
G000	G000 Cover Sheet		-
<u>Civil</u>			
Sheet #	Sheet Title	Issued Date	Rev
C-1	Paving, Grading & Drainage Plan	11/14/2023	-
C-2	Water & Sewer Plan	11/14/2023	-
C-3	Pavement Marking & Signage Plan	11/14/2023	-
C-4	Stormwater Pollution Prevention Plan	11/14/2023	-
C-5	Stormwater Pollution Prevention Notes & Details	11/14/2023	_
C-6	Details 11/14/2023		-
C-7	Details 11/14/2023		-
C-8	Details	11/14/2023	-
Archi	tectural		
Sheet #	Sheet Title	Issued Date	Rev
A001	Architectural Site Plan	11/14/2023	-
A002	Site Plan Details	11/14/2023	-
A003	Site Details	11/14/2023	-
A101	Proposed Floor Plan	11/14/2023	-
A301	Existing/Proposed Exterior Elevations	11/14/2023	

Drawing Index

Gene ₁	<u>ral</u>		
Sheet #	Sheet Title	Issued Date	Rev
G000	Cover Sheet	11/14/2023	-
<u>Civil</u>			
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Sheet #	Sheet Title	Issued Date	Rev
A001	Architectural Site Plan	11/14/2023	-
A002	Site Plan Details	11/14/2023	-
A003	Site Details	11/14/2023	_

Sheet Number Legend

<u>DRAWING SERIES</u>:

SHEET NUMBER/ZONE

O GENERAL, SYMBOLS, ABBREV., NOTES,

INTERIOR ELEVATIONS AND DETAILS

9 REFLECTED CEILING AND FINISH PLANS

SITE PLAN, LIFE SAFETY PLAN

FLOOR PLANS, ROOF PLAN

ENLARGED FLOOR PLANS

BUILDING ELEVATIONS

DOORS AND WINDOWS

BUILDING SECTIONS

EXTERIOR DETAILS

WALL SECTIONS

DRAWING SERIES —

DISCIPLINE -

DRAWING DISCIPLINE

ARCHITECTURAL

FIRE PROTECTION

STRUCTURAL MECHANICAL

ELECTRICAL

PLUMBING

EQUIPMENT

SK ASI SKETCHES

GENERAL

CIVIL LANDSCAPE

Demolition of Existing Storage Building for

Stone Road Energy, LLC

2511 NW 6th Street, Fort Lauderdale,

Florida 33311

November 28, 2022

	Revisions				
NO.	DATE	DESCRIPTION			
	п	raigat Data			

	Projec	t Data			
PROJECT:	FL220620.00	DRAWN BY:	ММ		
SCALE:	AS NOTED	CHECKED BY:	TR		
DATE:	11/28/2022	APPROVED BY:	TR		
DIRECTORY PATH:					

R: \Projects\FL220620.00\CAD\Architecture SHEET TITLE:

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Cover Sheet

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HOT WATER UNDERWRITERS LABORATORIES INC EACH WAY **MANUFACTURER** ELECTRIC(AL) VENT THROUGH ROOF ELECTRIC WATER COOLER MAXIMUM VINYL COMPOSITION TILE **EXPANSION JOINT** EXTERIOR INSULATION CAST IRON EQUIP. RM EQUIPMENT ROOM RIGHT HAND WITH MISCELLANEOUS CB WITHOUT CATCH BASIN FS FAR SIDE NEAR SIDE RISER CFCI CONTRACTOR FURNISHED. ROOF DRAIN FINISH(ED) NOMINAL WOOD CONTRACTOR INSTALLED FIRE ALARM WORK POINT NOT IN CONTRACT ROUGH OPENING FEC CLG FIRE EXTINGUISHER CAB. NTS NOT TO SCALE SECT INSIDE DIAMETER CEM FHC CEMENT FIRE HOSE CABINET NUMBER INSULAT(E)(D)(ION) CENTERLINE / COLUMN LINE FH FIRE HYDRANT ON CENTER SLOPE INTERIOR OFCI SOL CERAMIC TILE OWNER FURNISHED, SOLID INVERT CONTRACTOR INSTALLED CLEAN OUT SOLID CORE FLOOR DRAIN **JANITOR** FT COL COLUMN OPPOSITE HAND SPEC SPECIFICATIONS JOINT FTG OPNG CONC CONCRETE OPENING SQ LAM LAMINATED

Abbreviations

HEATING, VENTILATING

HEATING

PARTITION WITH WALL PROTECTION TOILET ACCESSORY TAG DOOR TAG LAY IN ACOUSTICAL TILE WINDOW TYPE CEILING PANELS DEMOLITION TAG GYPSUM BOARD CEILING / SOFFIT PARTITION TYPE EQUIPMENT TAG CEILING HEIGHT INDICATOR ABOVE FINISHED FLOOR ROOM TAG 123 LETTERED KEY NOTE ELEVATION TAG FRAMED PARTITION MASONRY PARTITION 1 / A201 EXISTING PARTITION TO REMAIN EXISTING PARTITION TO BE REMOVED ENLARGED PLAN / DETAIL LIMIT OF WORK PATH OF TRAVEL REVISION CLOUD/DELTA SPOT ELEVATION CORNER GUARD

Symbols

Project Reference

- SCAN THE QR CODES BELOW USING A SMARTPHONE OR TABLET FOR ADDITIONAL PROJECT RELATED INFORMATION
- IF YOU DON'T HAVE A QR CODE READER INSTALLED ON YOUR SMART PHONE OR TABLET, SIMPLY DOWNLOAD ONE BY GOING TO THE APP STORE AND SEARCHING FOR QR READER.

OPP

PTD

PNL

PTN

PLAS

PLAM

PWD

OPPOSITE

PAINTED

PANEL

PARTITION

PLASTIC LAMINATE

PLASTER

PLATE

PLYWOOD



(SCAN WITH TABLET)

CONCRETE MASONRY UNIT

CONTINUOUS

DEGREE(S)

DEMOLISH

DETAIL

CONTROL JOINT

CORNER GUARD

CMU

CONT

CTR

DEG

DEMO







STAINLESS STEEL

STANDARD

STORM DRAIN

SLAB OPENING

STRUCTURAL

SUSPENDED

TEMPERED/TEMPERATURE

STD

STL

S.O.

SFC

STRUCT

REQUEST DRAWINGS

THE GROUP|LOGIN PORTAL MAY BE USED TO REQUEST DRAWINGS AND CAD FILES, TRANSFER SHOP DRAWINGS AND SUBMITTALS, ADDRESS REQUESTS FOR INFORMATION (RFIs), PAY INVOICES, AND MORE.

DIRECTORY

CONTACT THE RADAKOVICH GROUP AT (877) 283-2470 OR EMAIL US AT INFO@RADAKOVICHINC.COM TO SETUP A GROUP|LOGIN ACCOUNT AND FOR MORE INFORMATION ON AVAILABLE RESOURCES USING THE GROUP LOGIN WEB PORTAL.

Project Information

<u> APPLICABLE CODES:</u>

FLORIDA BUILDING CODE, 2020 (7TH EDITION), INCLUDING NATIONAL ELECTRICAL CODE (NEC 2017) AND FLORIDA FIRE PREVENTION CODE 2020 (7TH EDITION).

PROJECT SCOPE DESCRIPTION:

THIS PROJECT INCLUDES THE RENOVATION TO AN EXISTING ONE-STORY STORAGE BUILDING INTO A OFFICE & STORAGE SPACE LOCATED ON PARCEL 2 (SOUTH) OF THE SITE, COMBINED WITH REMAINING PARCEL 1 (NORTH) AND PARCEL 3 (WEST) OF THE SITE TO BE REDEVELOPED FOR PROPANE STORAGE AT 2511 NW 6th AVENUE, FORT LAUDERDALE, FL 33311. THE WORK CONSISTS OF BUILDING RENOVATIONS INCLUDING NEW DOORS AND WINDOWS, EXTERIOR WALL FINISHES, ENTRY CANOPY, AND INTERIOR BUILD-OUT CONSISTING OF NEW INTERIOR WALLS AND FINISHES THROUGHOUT, PLUMBING FIXTURES & APPLIANCES, POWER & LIGHTING, AND ac DUCTS & DIFFUSERS. IN ADDITION, THE REMAINING PARCELS 1 AND 3 WILL BE RE-PAVED AND GRADED, INCLUDING NEW PARKING AREAS, CURBS, LANDSCAPE, FENCES AND GATES, AND LIGHT POLES THROUGHOUT THE SITE.

REFER TO ADDITIONAL INFORMATION AS OUTLINED IN THE ARCHITECTURAL, CIVIL AND LANDSCAPE SHEETS IN THESE DOCUMENTS.

<u>AUTHORITY HAVING JURISDICTION:</u> BROWARD COUNTY BUILDING SERVICES 2307 W BROWARD BLVD FORT LAUDERDALE, FL 33312


PH: (954) 765-4400


PROJECT ADDRESS: 2511 NW 6th STREET FORT LAUDERDALE, FL 33311


> ALL DRAWINGS, SPECIFICATIONS AND RELATED DOCUMENTS ARE COPYRIGH PROPERTY OF THE ARCHITECT AND MUST BE RETURNED UPON REQUEST. REPRODUCTION OF DRAWINGS, SPECIFICATIONS AND RELATED DOCUMENTS IN PART OR WHOLE IS FORBIDDEN WITHOUT THE ARCHITECT'S EXPRESS


TO THE BEST OF THE ARCHITECT'S OR ENGINEER'S KNOWLEDGE, THE PLANS AND SPECIFICATIONS CONTAINED HEREIN COMPLY WITH THE APPLICABLE MINIMUM BUILDING CODES AND THE APPLICABLE FIRE SAFETY STANDARDS AS DETERMINED BY THE LOCAL AUTHORITY IN ACCORDANCE WITH FLORIDA STATUTES, CHAPTER 633.


WRITTEN PERMISSION

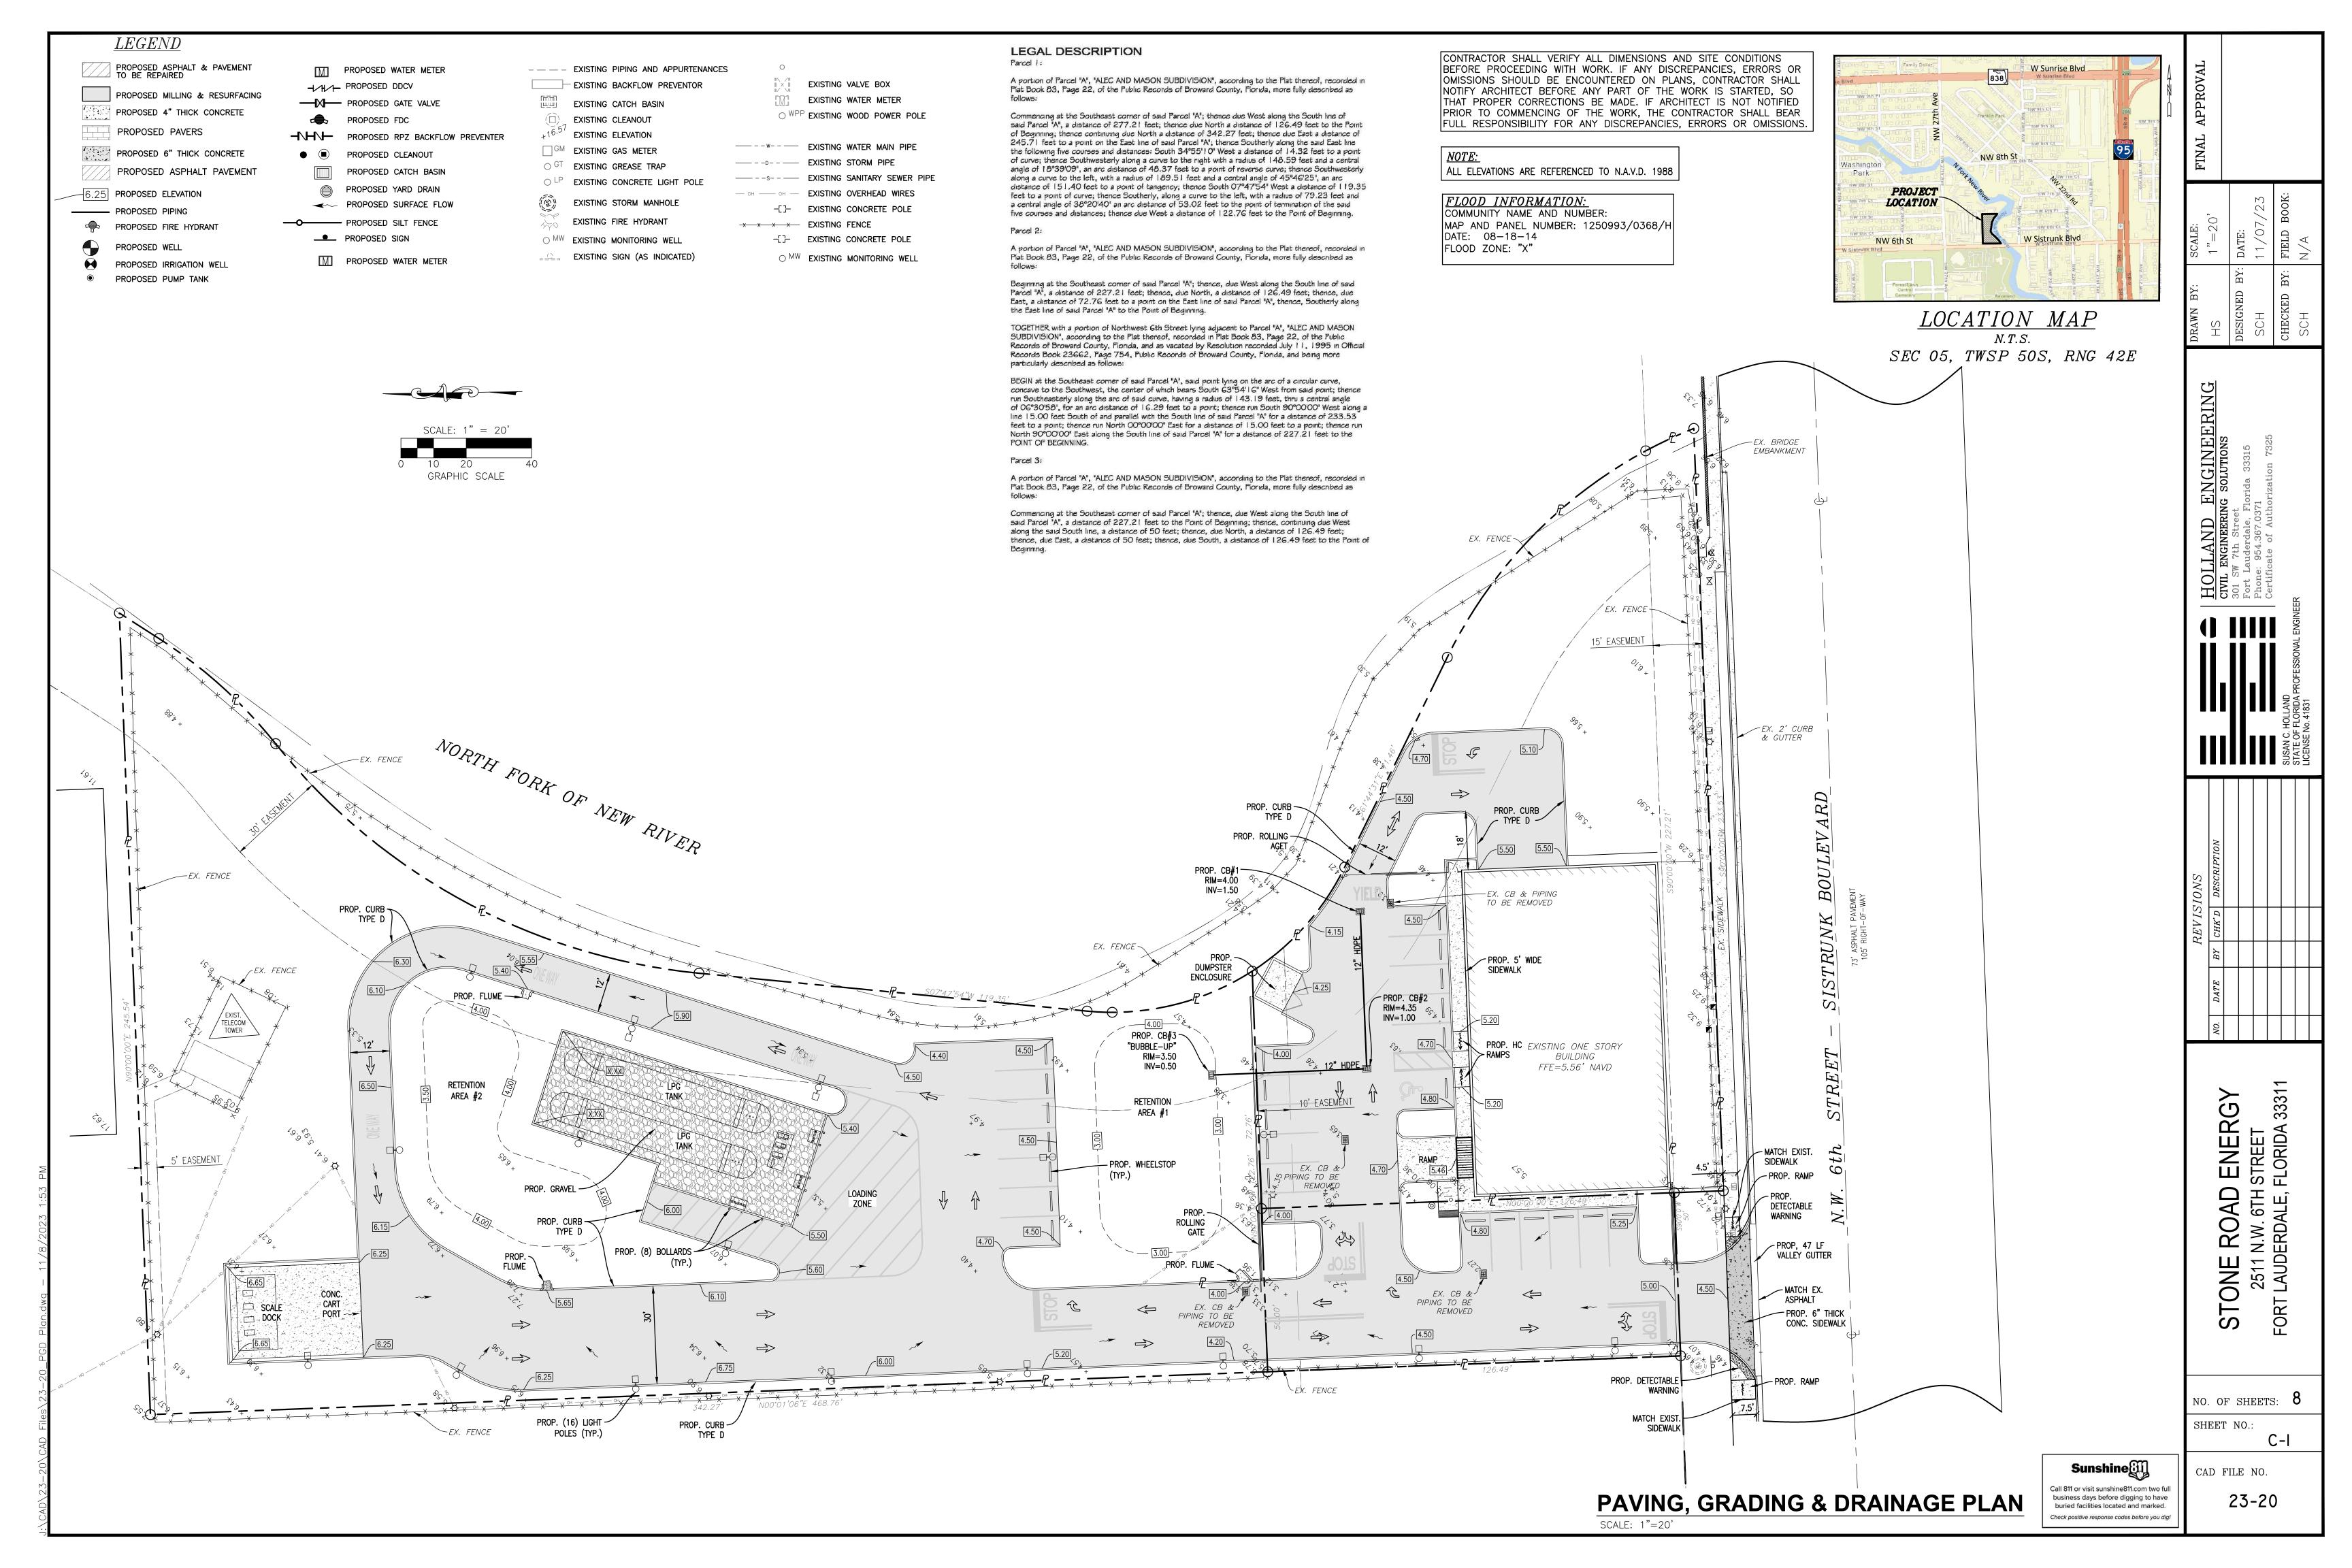

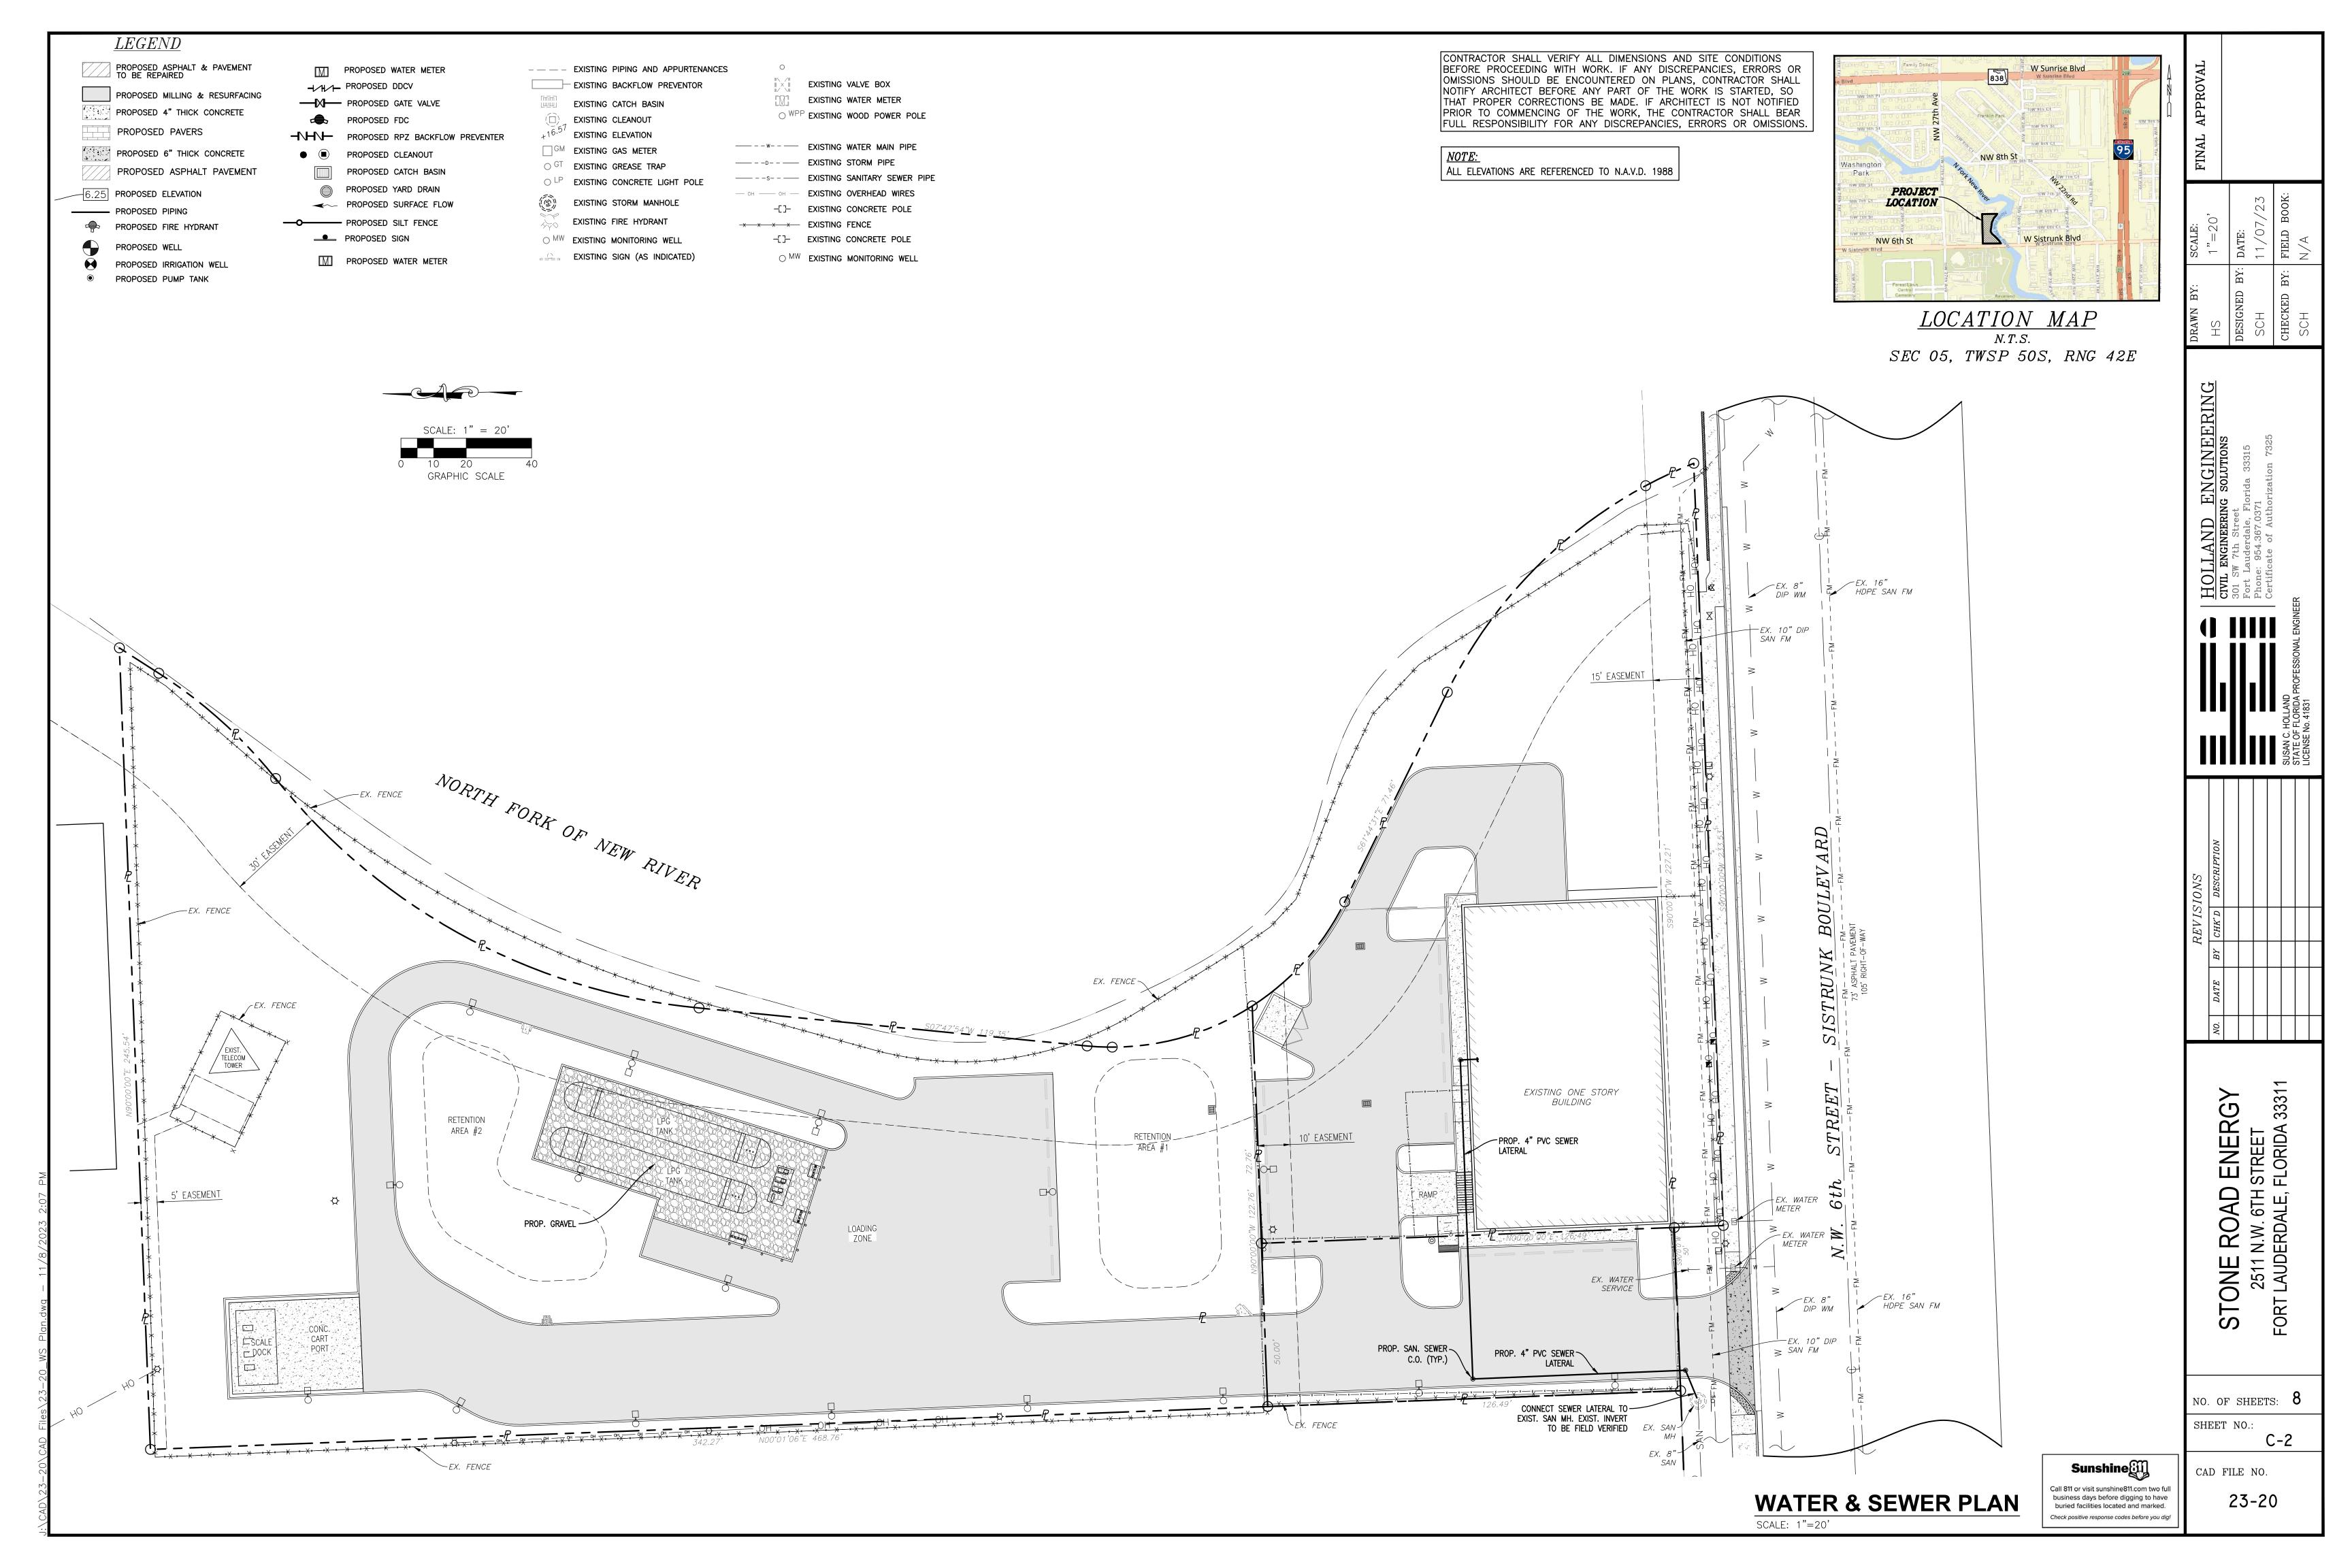

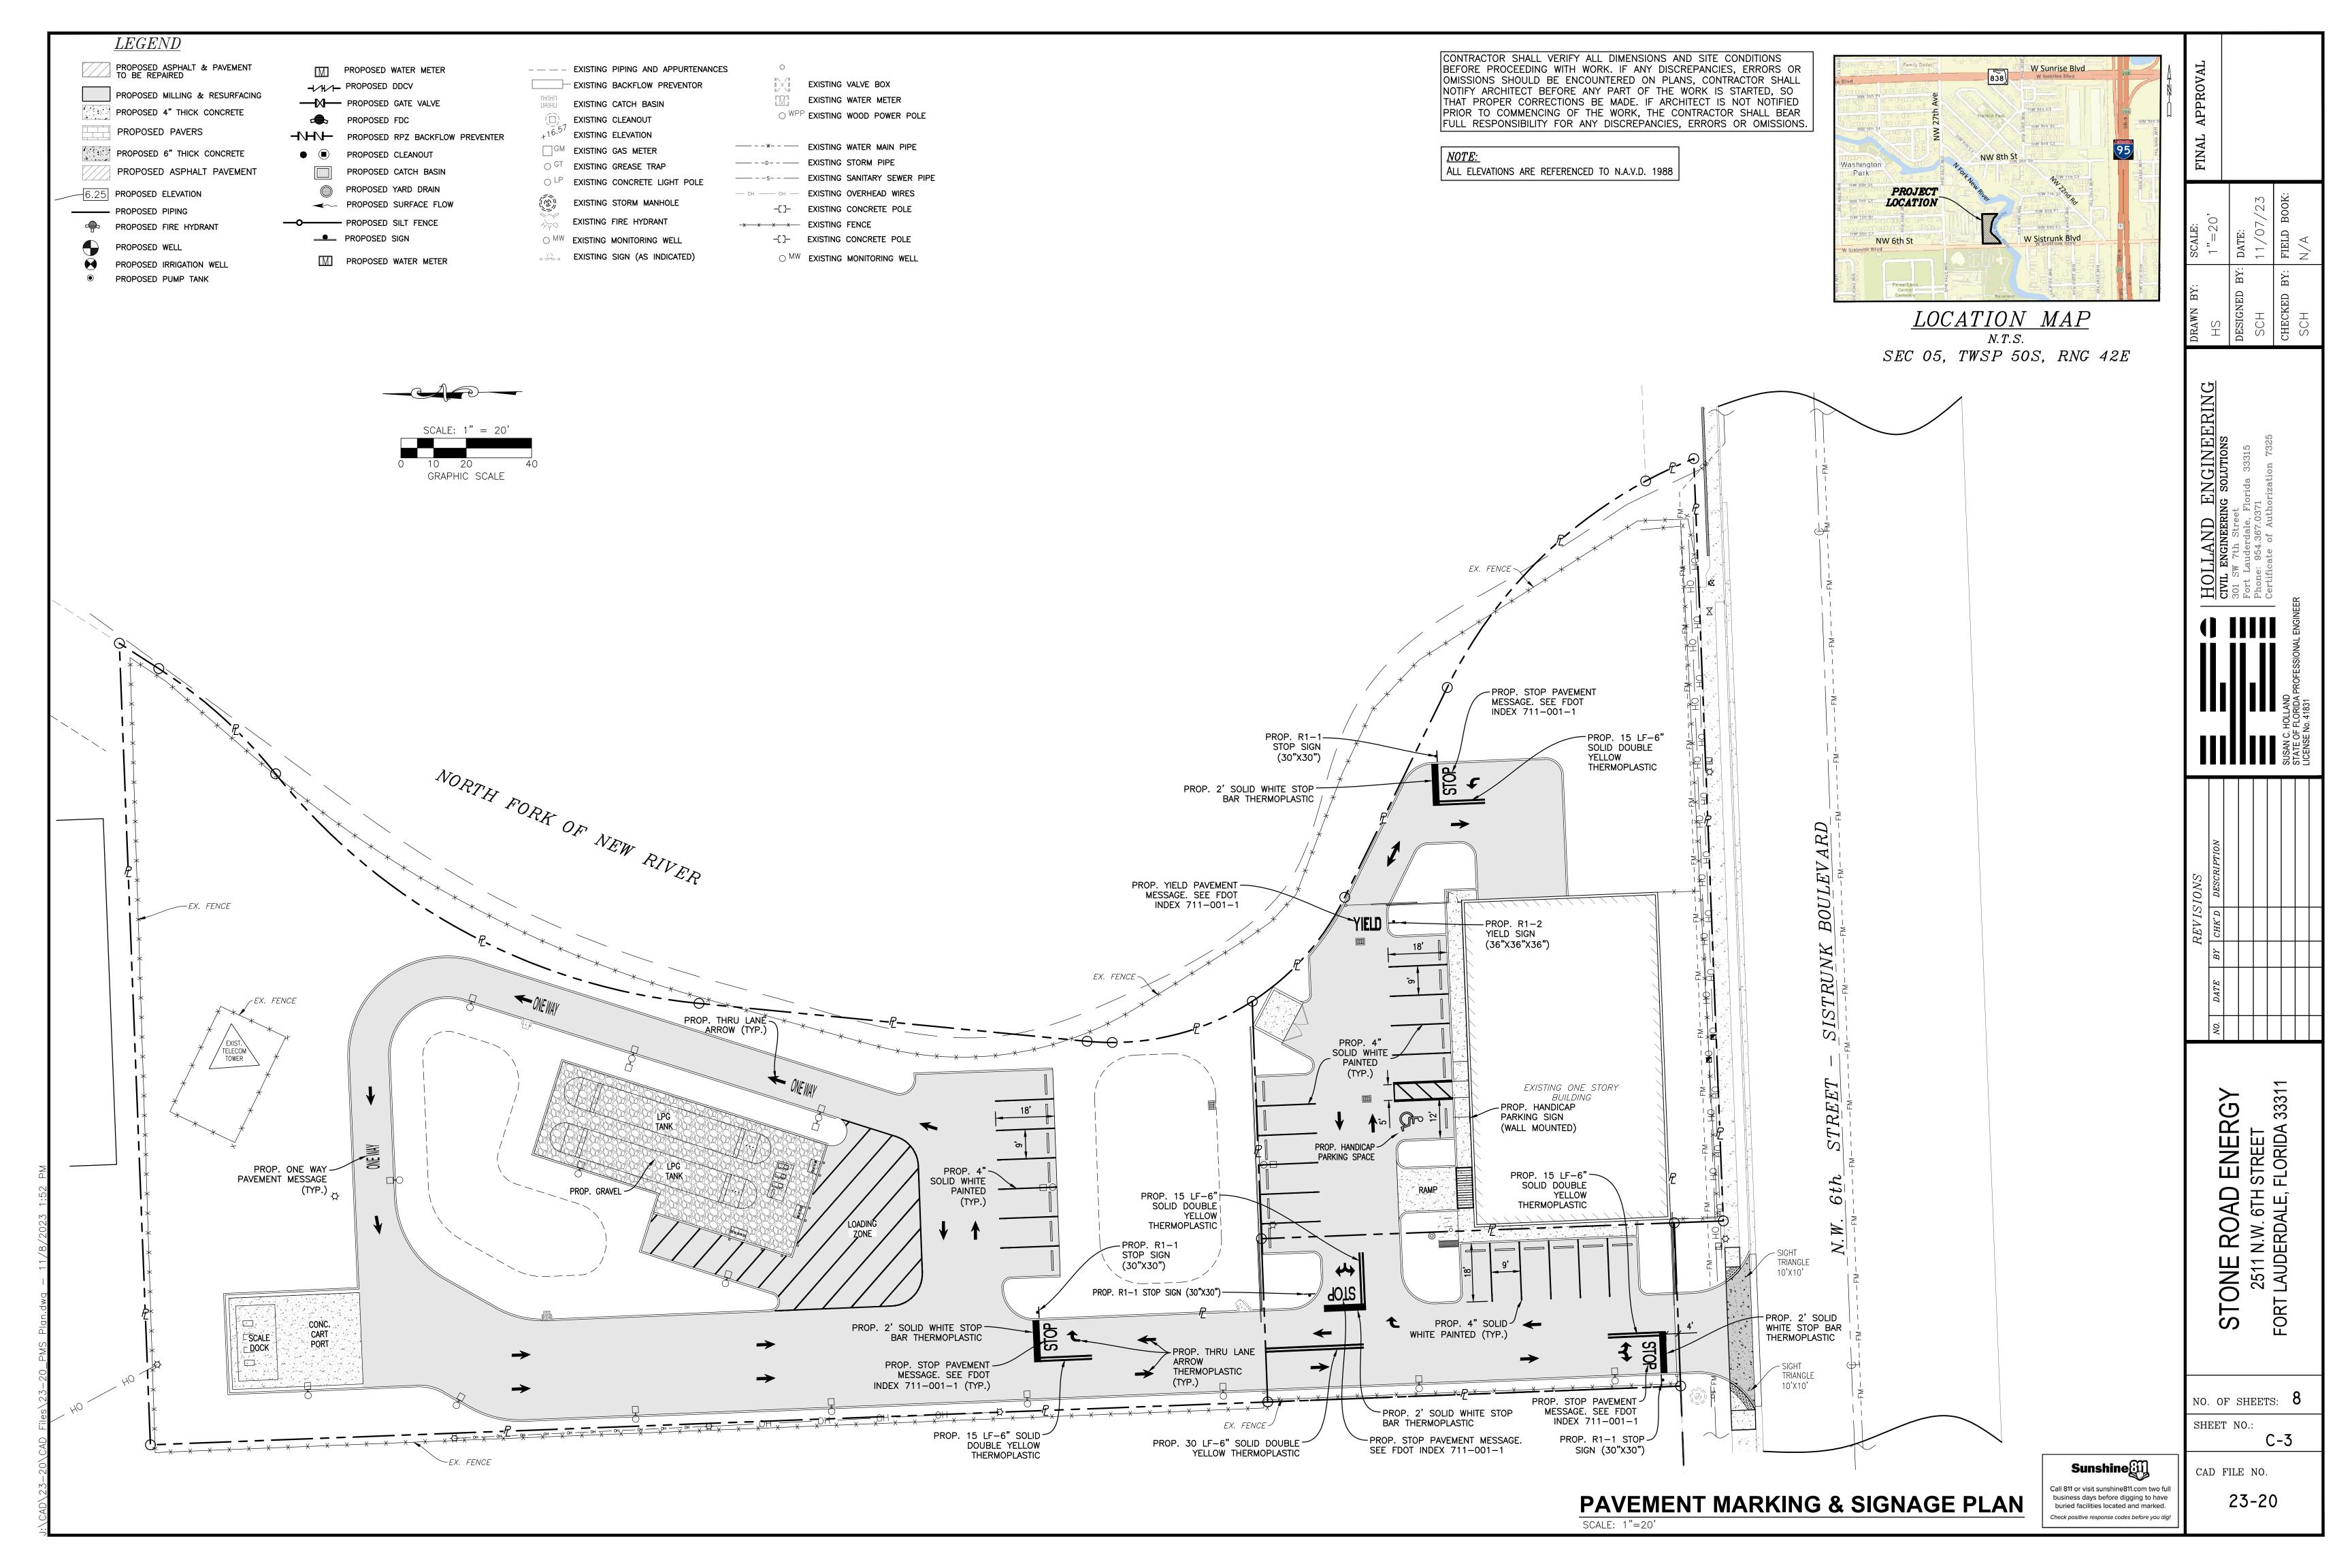

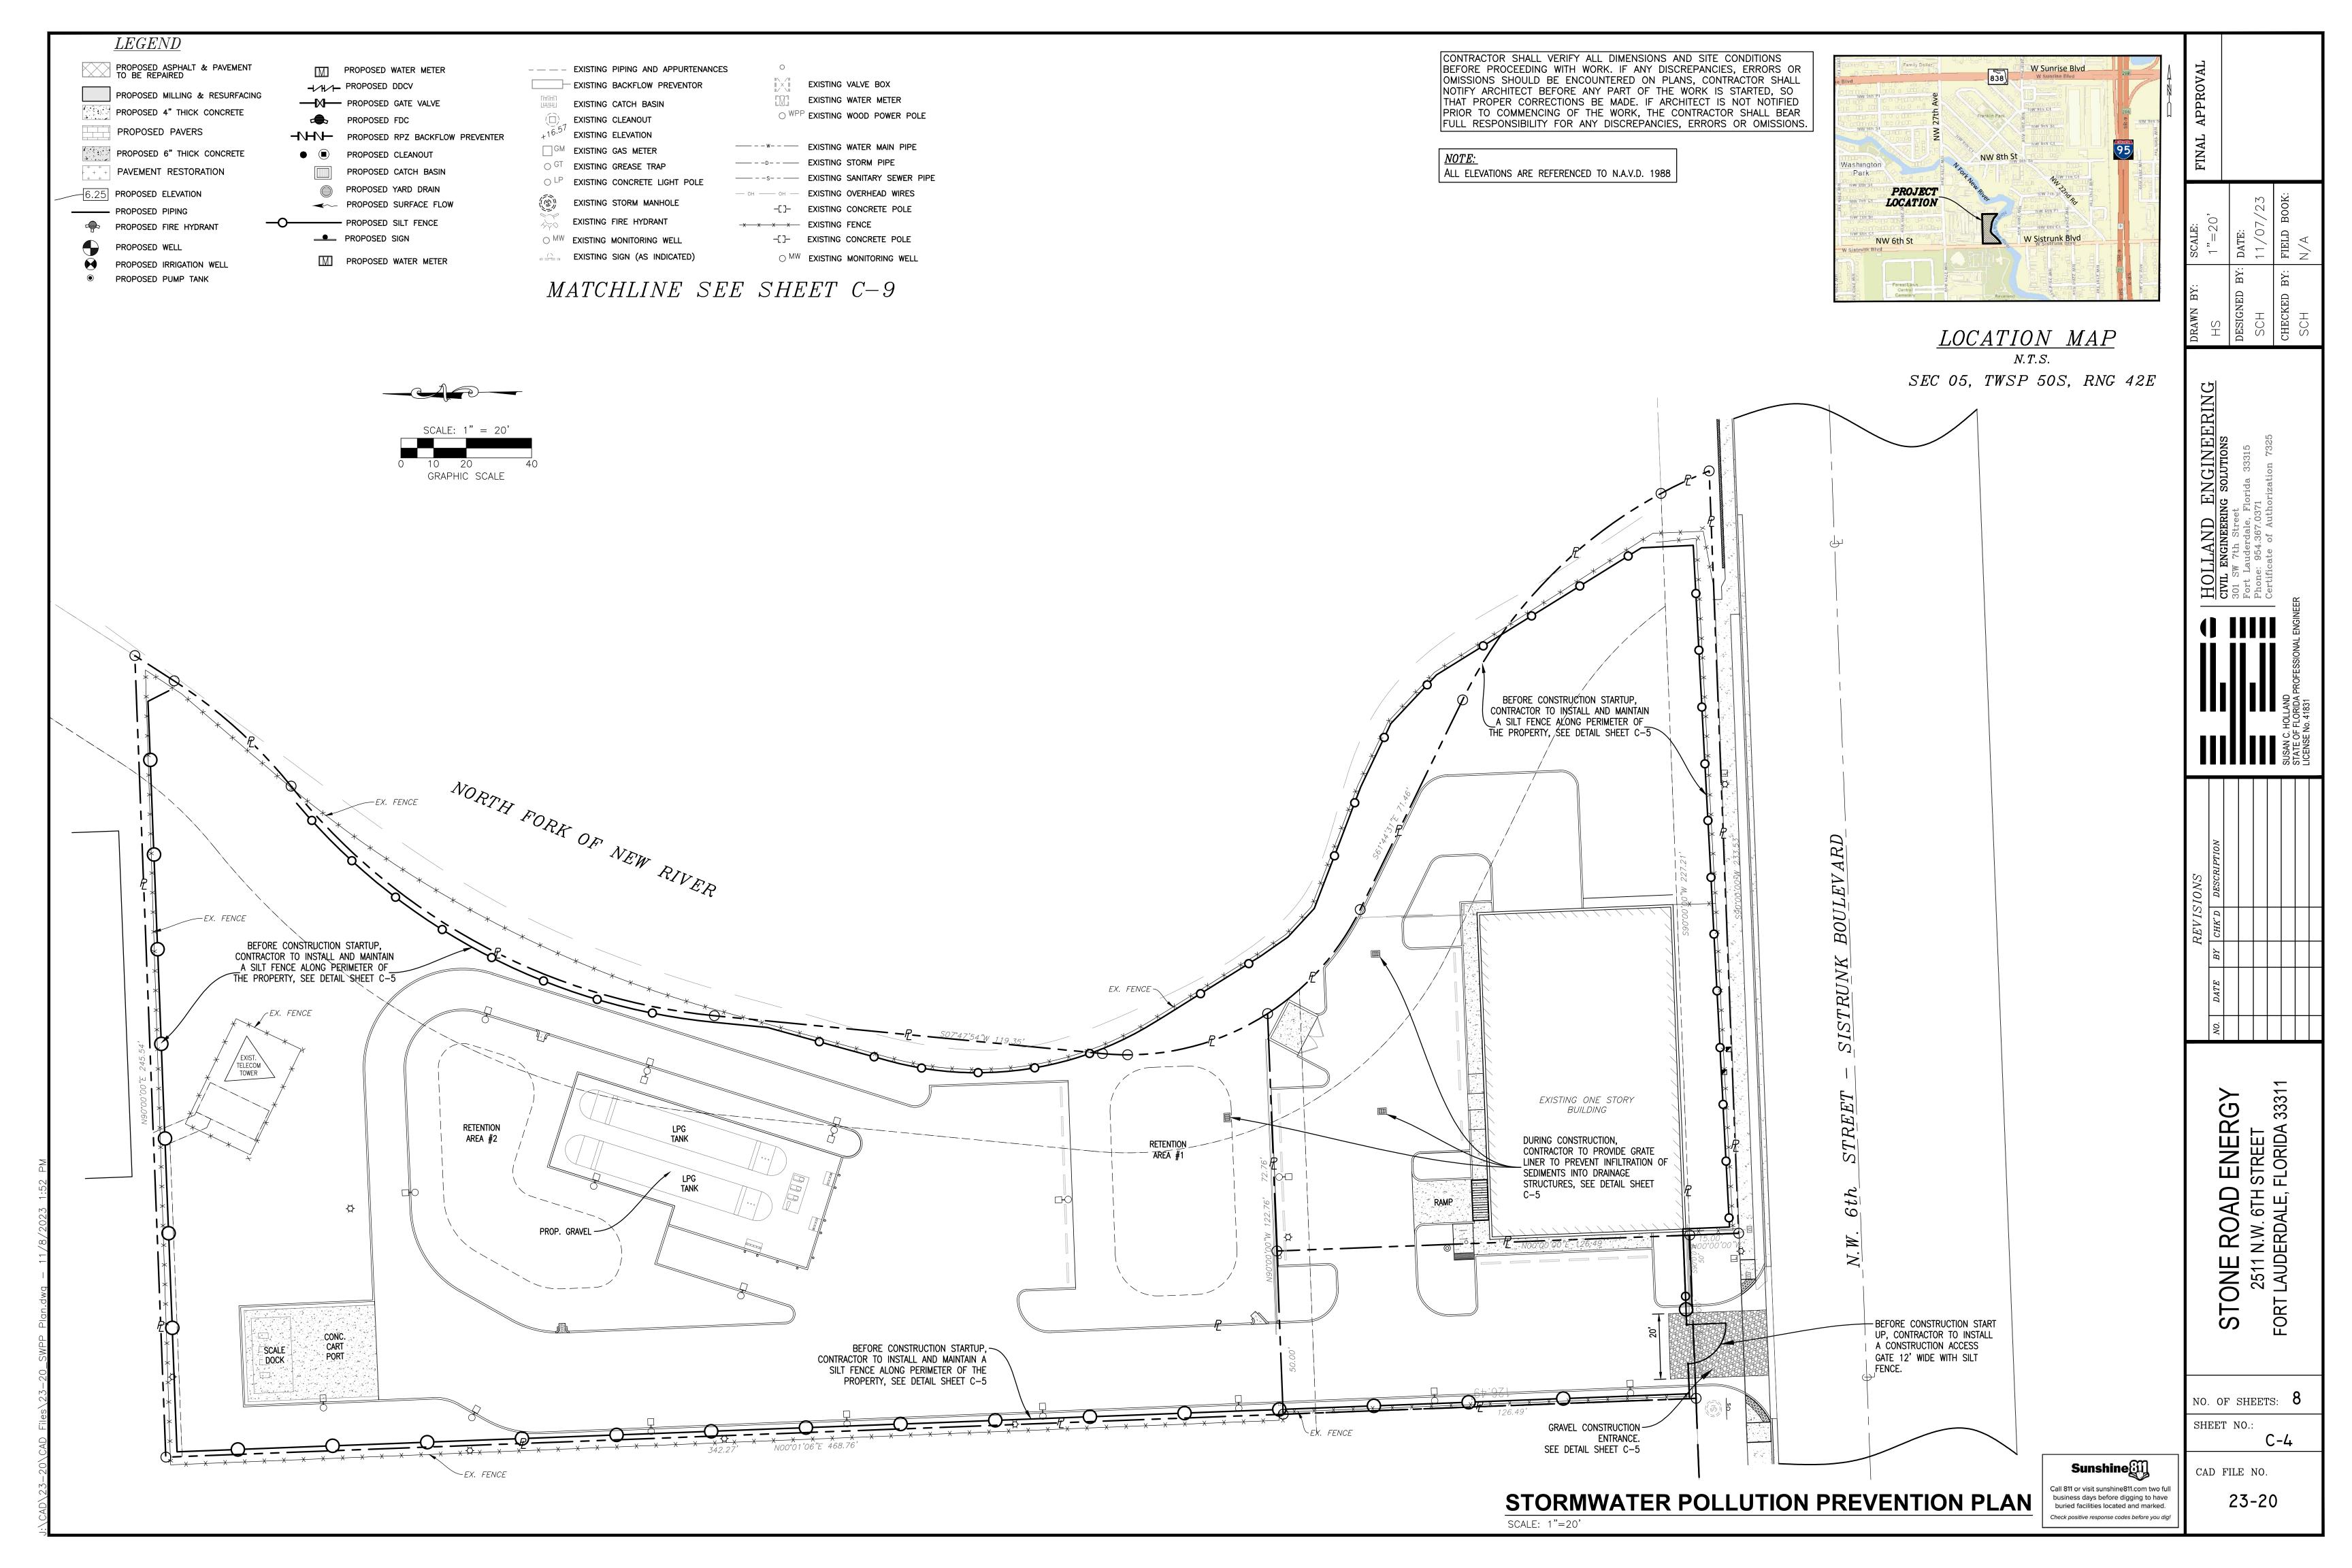

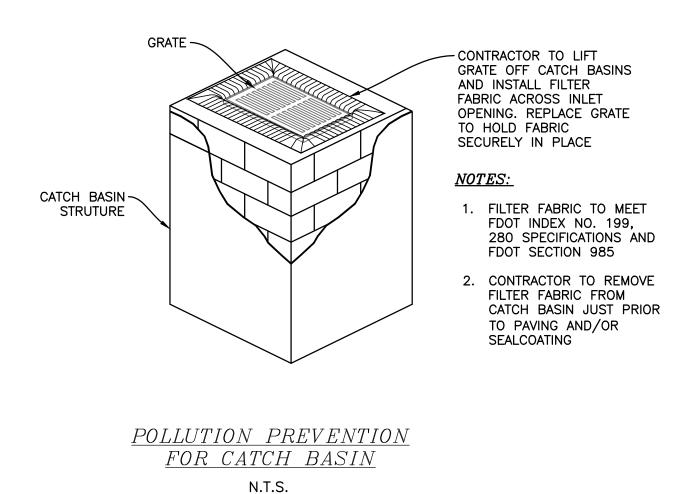

PROP. 6" FDOT #1
COURSE AGGREGATE PROP. FILTER CLOTH <u>GRAVEL ENTRANCE/EXIT - DURING</u> CONSTRUCTION DETAIL

N.T.S.

BMP NOTES:

I. ALL SEDIMENT CONTROL MEASURES ARE TO BE ADJUSTED TO MEET FIELD CONDITIONS AT THE TIME OF CONSTRUCTION AND BE CONSTRUCTED PRIOR TO ANY GRADING OR DISTURBANCE OF EXISTING SURFACE MATERIAL ON BALANCE OF SITE. PERIMETER SEDIMENT BARRIERS SHALL BE CONSTRUCTED TO PREVENT SEDIMENT OR TRASH FROM FLOWING OR FLOATING ON TO ADJACENT

2. PERIODIC INSPECTION AND MAINTENANCE OF ALL SEDIMENT CONTROL STRUCTURES MUST BE PROVIDED TO ENSURE INTENDED PURPOSE IS ACCOMPLISHED. THE DEVELOPER, OWNER AND/OR CONTRACTOR SHALL BE CONTINUALLY RESPONSIBLE FOR ALL SEDIMENT CONTROLS. SEDIMENT CONTROL MEASURES SHALL BE IN WORKING CONDITION AT THE END OF EACH WORKING DAY.

3. SEDIMENT WILL BE PREVENTED FROM ENTERING ANY STORM WATER SYSTEM, DITCH OR CHANNEL. ALL STORMWATER INLETS THAT ARE MADE OPERABLE DURING CONSTRUCTION SHALL BE PROTECTED SO THAT SEDIMENT-LADEN WATER CANNOT ENTER THE CONVEYANCE SYSTEM WITHOUT FIRST BEING FILTERED OR OTHERWISE TREATED TO REMOVE SEDIMENT.

4. WHERE CONSTRUCTION VEHICLE ACCESS ROUTES INTERSECT PAVED PUBLIC ROADS, PROVISIONS SHALL BE MADE TO MINIMIZE THE TRANSPORT OF SEDIMENT BY TRACKING ONTO THE PAVED SURFACE. WHERE SEDIMENT IS TRANSPORTED ONTO A PUBLIC ROAD SURFACE WITH CURBS AND GUTTERS, THE ROAD SHALL BE CLEANED THOROUGHLY AT THE END OF EACH DAY. SEDIMENT SHALL BE REMOVED FROM THE ROADS BY SHOVELING OR SWEEPING AND TRANSPORTED TO A SEDIMENT CONTROL DISPOSAL AREA. STREET WASHING SHALL BE ALLOWED ONLY AFTER SEDIMENT IS REMOVED IN THIS MANNER. THIS PROVISION SHALL APPLY TO INDIVIDUAL SUBDIVISION LOTS AS WELL AS TO LARGER LAND DISTURBING ACTIVITIES.

5. PERMANENT OR TEMPORARY SOIL STABILIZATION SHALL BE APPLIED TO DENUDED AREAS WITHIN SEVEN (7) DAYS AFTER FINAL GRADE IS REACHED ON ANY PORTION OF THE SITE. TEMPORARY SOIL STABILIZATION SHALL BE APPLIED WITHIN SEVEN (7) DAYS TO DENUDED AREAS THAT MAY NOT BE AT FINAL GRADE BUT WILL REMAIN UNDISTURBED FOR LONGER THAN THIRTY (30) DAYS. PERMANENT STABILIZATION SHALL BE APPLIED TO AREAS THAT ARE TO BE LEFT UNDISTURBED FOR MORE THAN ONE YEAR.

6. DURING CONSTRUCTION OF THE PROJECT, SOIL STOCKPILES SHALL BE STABILIZED, COVERED OR CONTAINED WITH SEDIMENT TRAPPING MEASURES. THE CONTRACTOR IS RESPONSIBLE FOR THE TEMPORARY PROTECTION AND PERMANENT STABILIZATION OF ALL SOIL STOCKPILES ON SITE AS WELL AS SOIL INTENTIONALLY TRANSPORTED FROM THE PROJECT SITE.

7. ALL TEMPORARY EROSION AND SEDIMENT CONTROL MEASURES SHALL BE REMOVED WITHIN 30 DAYS AFTER FINAL SITE STABILIZATION OR AFTER THE TEMPORARY MEASURES ARE NO LONGER

- 8. PROPERTIES AND WATER WAYS DOWNSTREAM FROM CONSTRUCTION SITE SHALL BE PROTECTED FROM SEDIMENT DEPOSITION AND EROSION AT ALL TIMES DURING CONSTRUCTION.
- 9. CONTRACTOR IS RESPONSIBLE FOR ALL SURFACE WATER DISCHARGES, RAINFALL RUN OFF OR DEWATERING ACTIVITIES.
- 10. CONTRACTOR MUST INCORPORATE ALL BMP'S NECESSARY TO MEET OR EXCEED STATE WATER QUALITY AND SWPPP REQUIREMENTS.
- 11. THE POLLUTION PREVENTION PLAN IS A MINIMUM GUIDELINE ONLY. ADDITIONAL BMP'S MAY BE NECESSARY AT CONTRACTOR'S EXPENSE. TO MEET LEED REQUIREMENTS.
- 12. PROVIDE SILT FENCE AROUND WORK AREA DURING INSTALLATION OF NEW 8" SANITARY SEWER MAIN.


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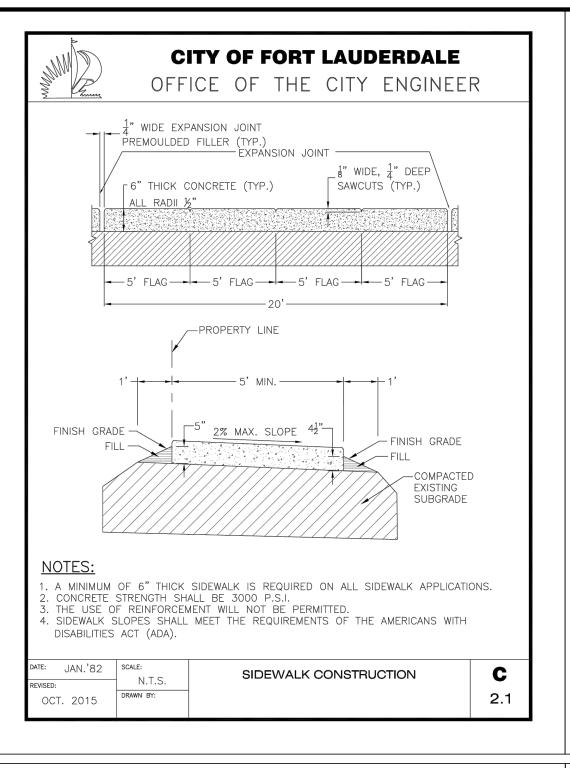
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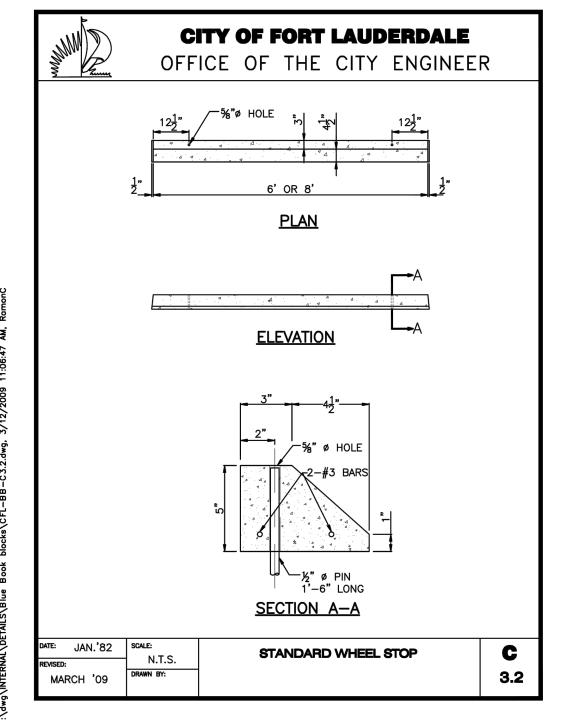
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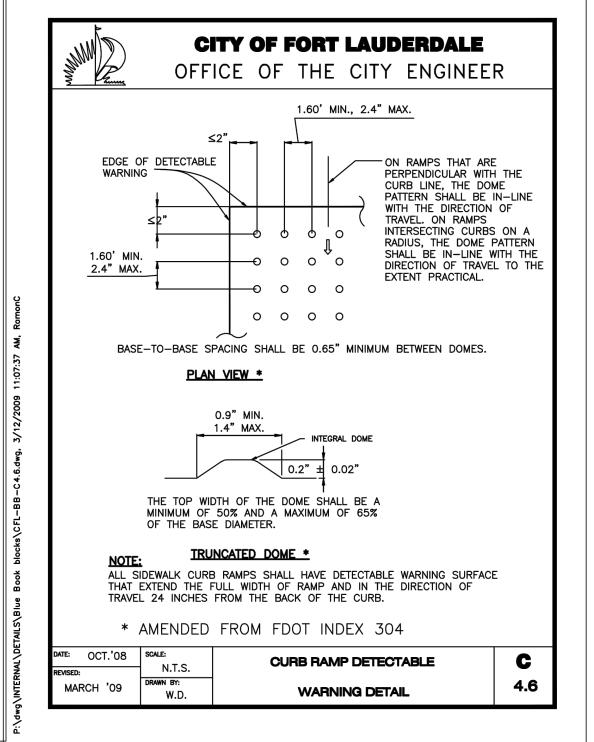
STORMWATER POLLUTION PREVENTION NOTES & DETAILS


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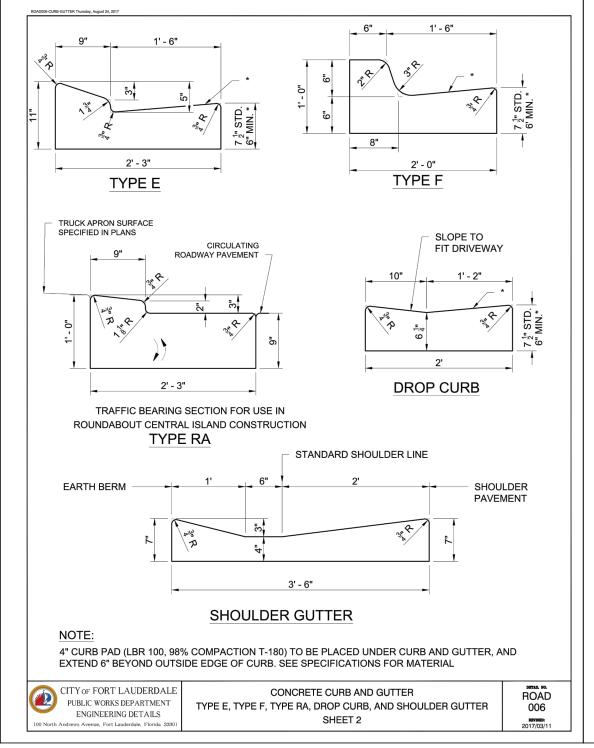










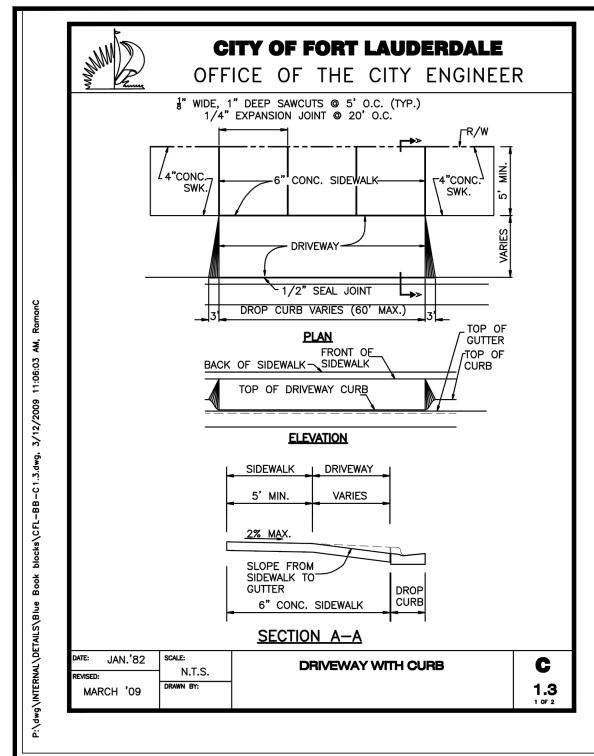

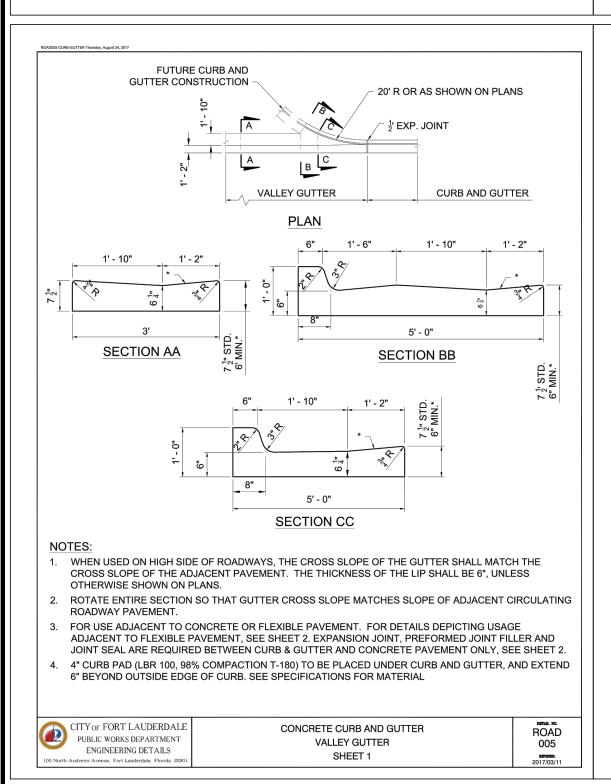

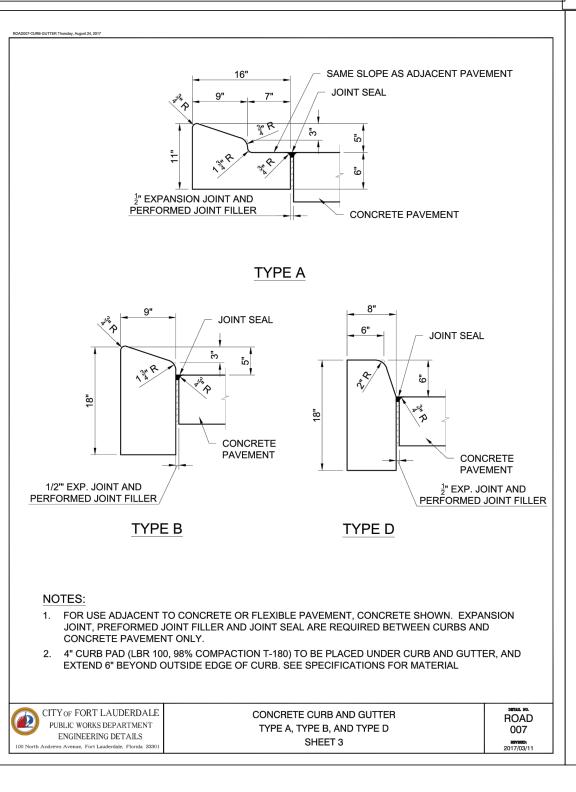

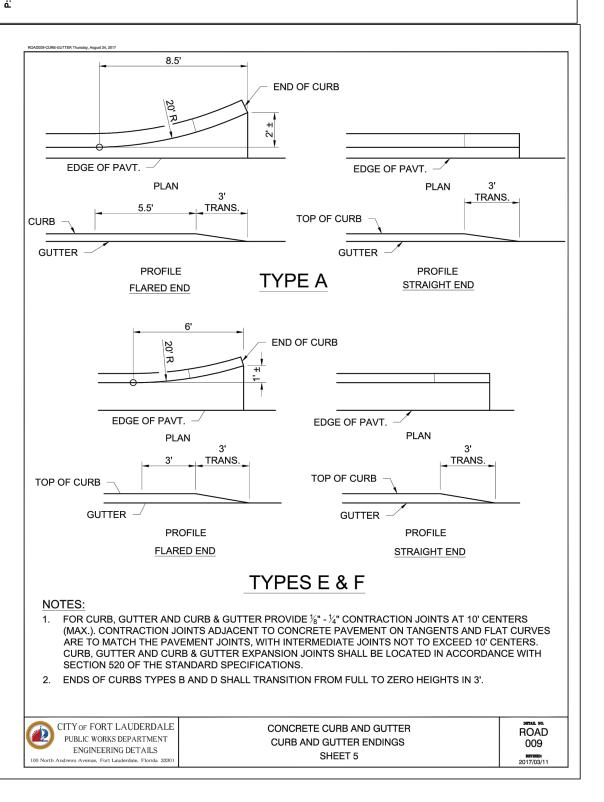

ENGINEERING NG SOLUTIONS ERGY


ENER STREET FLORIDA STONE FORT


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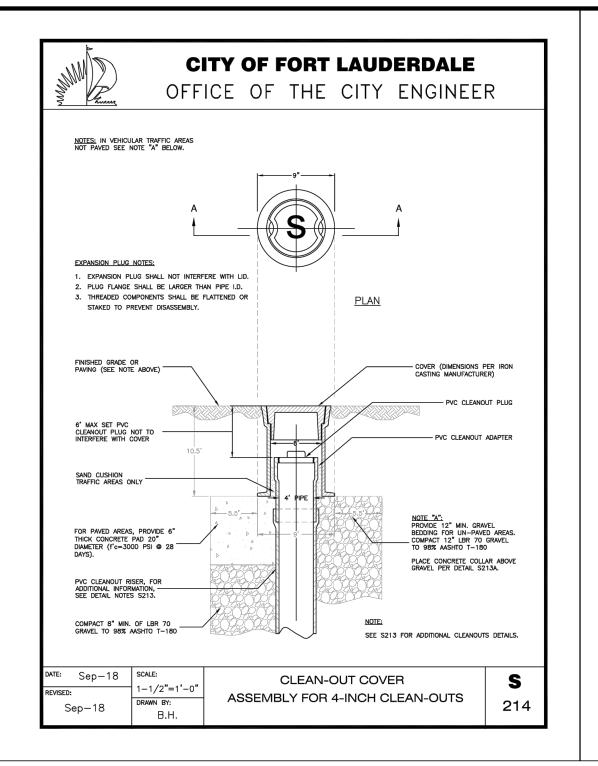
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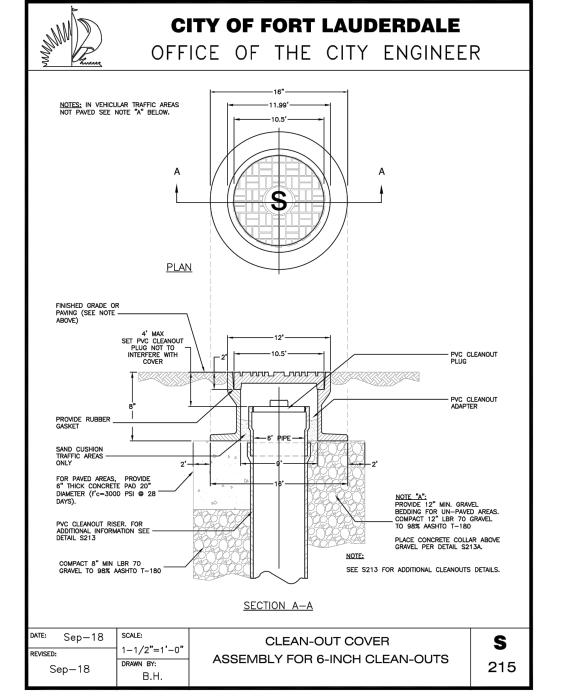
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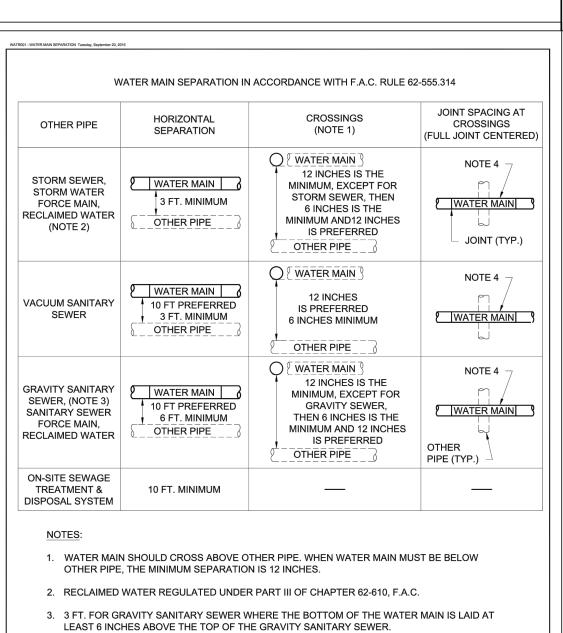
DETAILS







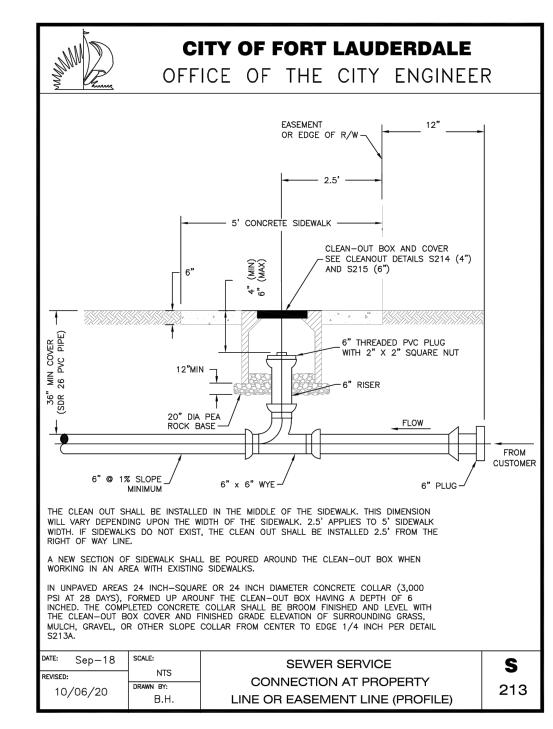

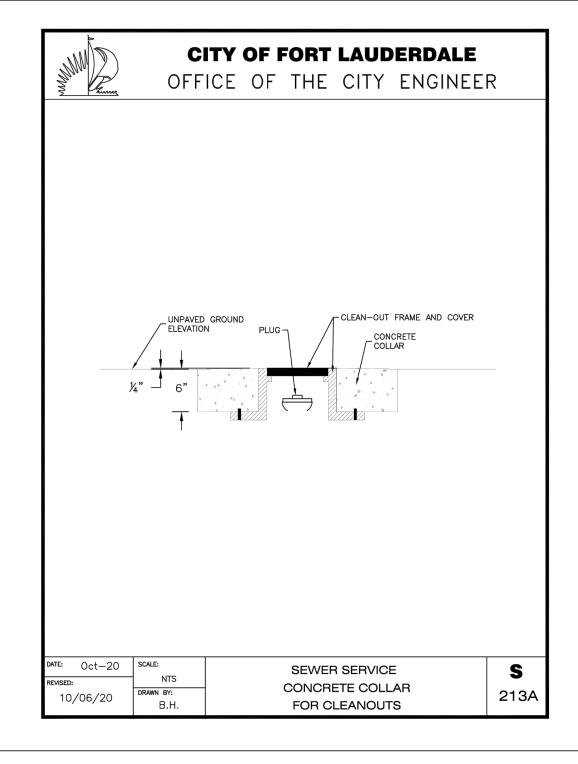

4. ONE FULL LENGTH OF WATER MAIN PIPE SHALL BE CENTERED ABOVE OR BELOW THE OTHER PIPE SO THAT THE WATER MAIN JOINTS WILL BE AS FAR AS POSSIBLE FROM THE OTHER PIPELINE. ALTERNATE JOINT LOCATIONS ALLOWED UNDER FAC 62-555.314 WILL


WATER MAIN SEPARATION

WATR 001

ONLY BE ALLOWED BY THE ENGINEER ON A CASE-BY-CASE BASIS.

CITY OF FORT LAUDERDALE
PUBLIC WORKS DEPARTMENT

ENGINEERING DETAILS

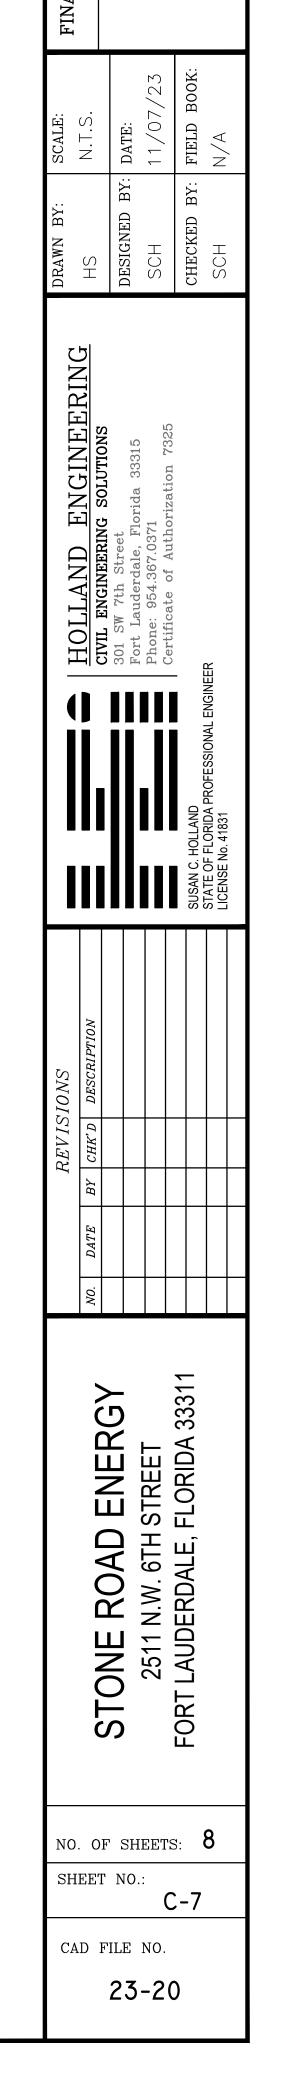

DETAILS SCALE: N.T.S.

